### **ORDINANCE NO. 3070**

AN ORDINANCE RELATED TO ZONING; RECLASSIFYING APPROXIMATELY 6.5± ACRES IN THE ZONING MAP OF NORTH LAS VEGAS FROM A C-2, GENERAL COMMERCIAL DISTRICT TO A PUD, PLANNED UNIT DEVELOPMENT DISTRICT (ZN-03-2021, NOBLE PEAK) FOR A 70-LOT, SINGLE-FAMILY ATTACHED SUBDIVISION FOR PROPERTY LOCATED WEST OF SCOTT ROBINSON BOULEVARD AND APPROXIMATELY 581 FEET NORTH OF CRAIG ROAD AND PROVIDING FOR OTHER MATTERS PROPERLY RELATING THERETO.

WHEREAS, the rezoning is consistent with the Comprehensive Plan; and

**WHEREAS**, the Council determines that the amendment will not adversely affect the health and general welfare; and,

**WHEREAS**, according to Paragraph B of Section 70 of Chapter 12 of Title 17 of the North Las Vegas Municipal Code, the City Council may, by ordinance, reclassify property.

**NOW THEREFORE**, the City Council of the City of North Las Vegas does ordain:

**SECTION 1**: In accordance with the provisions of Ordinance No. 3070, the following described parcel of land shall be reclassified as follows:

FROM C-2, GENERAL COMMERCIAL DISTRICT TO PUD, PLANNED UNIT DEVELOPMENT DISTRICT (ZN-03-2021), THE FOLLOWING PROPERTY DESCRIBED TO WIT:

APN: 139-04-201-021

### **EXHIBIT "A"**

**EXPLANATION:** 

THIS DESCRIPTION REPRESENTS THE BOUNDARY OF THE "NOBLE PEAK" PROJECT.

### **DESCRIPTION**

ALL OF LOT 2 AS SHOWN BY MAP THEREOF IN FILE 126, PAGE 50 OF PARCEL MAPS, IN THE CLARK COUNTY RECORDER'S OFFICE, NEVADA, LYING WITHIN THE SOUTHWEST QUARTER (SW1/4) OF THE NORTHWEST QUARTER (NW1/4) OF SECTION 4, TOWNSHIP 20 SOUTH, RANGE 61 EAST, M.D.M., CITY OF NORTH LAS VEGAS, CLARK COUNTY, NEVADA.

CONTAINING 6.48 ACRES, MORE OR LESS.

**SECTION 2**: The Planned Unit Development District (PUD) herein is subject to the development standards and requirements of the North Las Vegas Municipal Code as well as the following conditions of approval:

- 1. Unless expressly authorized through a variance, waiver or another approved method, this development shall comply with all applicable codes and ordinances.
- 2. A Final Development Plan for the 70-lot attached, single-family residential is required.

Ordinance No. 3070

- 3. The following amenities shall be provided within the open space areas: age appropriate playground equipment with EPDM surfacing; turfed open play areas; shaded picnic areas; and dog stations.
- 4. The landscaping that is provided between the units, the porches, and the garage area shall be maintained by the Home Owners Association.
- 5. Setbacks for the lots are as follows:
  - Front setback 12-feet
  - Porch setback 10-feet
  - Side yard setback building (interior) 5-feet
  - Side yard setback building (corner) 5-feet
  - Attached building to building setback 0-feet
  - Rear setback garage 4-feet
  - Rear setback living 4-feet
- 6. All known geologic hazards shall be shown on the preliminary development plan, tentative map and the civil improvement plans. Geological hazards such as fault lines or fissures affecting residential structures may substantially alter the tentative map layout and require the submission of a revised tentative map which must be approved by the City prior to final approval of the civil improvement plans. The footprint of proposed structures shall be plotted on all lots impacted by faults and/or fissures and a minimum width of five (5) feet shall be provided from the edge of any proposed structure to the nearest fault and/or fissure.
- 7. Approval of a drainage study is required prior to submittal of the civil improvement plans.
- 8. The street names shall be in accordance with the North Las Vegas Street Naming and Address Assignment Standards, and must be approved by the City of Las Vegas Central Fire Alarm Office.
- 9. The property owner is required to grant roadway easements where public and private streets intersect.
- 10. The property owner is required to grant a public pedestrian access easement for sidewalk located within a common element, or on private property, when that sidewalk is providing public access adjacent to the right-of-way.
- 11. The size and number of access points and their locations are subject to review and approval by the City of North Las Vegas Traffic Engineer and must meet the standards set forth in *North Las Vegas Municipal Code* Section 17.24.040. Conformance may require modifications to the site.
- 12. All driveway geometrics shall be in compliance with the *Uniform Standard Drawings for Public Works' Construction Off-Site Improvements* Drawing Numbers 222.1 and 222.
- 13. The public street geometrics and thickness of the pavement sections will be determined by the Department of Public Works.

- 14. All Nevada Energy easements, appurtenances, lines and poles must be shown and shall be located entirely within the perimeter landscape area of this development. Distribution lines, existing or proposed, shall be placed underground if impacted by the proposed development of the parcel or if the pole impedes upon the proper ADA clearances for sidewalk. Under no circumstances will new down guy wires be permitted.
- 15. Approval of a traffic study is required prior to submittal of the civil improvement plans. Please contact Traffic Engineering at 633-2676 to request a scope. A queuing analysis may be required.

SECTION 3: NON-INFRINGEMENT OF RIGHTS. The City Council of the City of North Las Vegas has been informed by the City Attorney as to the constitutionality of this ordinance and based upon such information we are adopting this ordinance in good faith with a reasonable belief that the actions taken by the City of North Las Vegas are not in violation of any rights, privileges, or immunities secured by the laws providing for equal rights of citizens or persons.

**SECTION 4**: SEVERABILITY. If any section, paragraph, clause or provision of this Ordinance shall for any reason be held to be invalid or unenforceable, the invalidity or unenforceability of such section, paragraph, clause, or provision shall in no way affect the validity and enforceability of the remaining provisions of this Ordinance.

**SECTION 5**: EFFECTIVE DATE. This Ordinance shall become effective after its passage by the City Council of the City of North Las Vegas and, after such passage by the City Council, publication once by title in a newspaper qualified pursuant to the provisions of Chapter 238 of NRS, as amended from time to time.

**SECTION 6**: PUBLICATION. The City Clerk shall cause this Ordinance, immediately following its adoption, to be published once by title, together with the names of the Councilmen voting for or against passage, in a newspaper qualified pursuant to the provisions of Chapter 238 of NRS, as amended from time to time.

PASSED AND ADOPTED THIS 5th day of May, 2021.

AYES: Mayor Lee, Mayor Pro Tempore Barron, Council Members Black,

Cherchio, and Goynes-Brown

NAYS: None ABSTAIN: None ABSENT: None

APPROVED:

JOHN J. LEE, MAYOR

ATTEST:

CATHERINE A. RAYNOR, MMC, CITY CLERK

### CITY OF NORTH LAS VEGAS INTEROFFICE MEMORANDUM

To: From: Amy Michaels, Principal Planner, Land Development & Community Services
Duane McNelly, Land Development Coordinator, Department of Public Works

Subject:

FDP 09-2021 Noble Peak

Date:

August 09, 2021

The Department of Public Works recommends that this item comply with the conditions of approval for ZN 03-21 as well as the following conditions stated below:

- 1. Appropriate subdivision mapping is required to complete this project. All mapping shall be in compliance with NRS Chapter 278 and the City of North Las Vegas Municipal Code, and associated Master Plans in effect at the time of subdivision and/or parcel map approval. (The final map has been submitted.)
- 2. All common elements shall be labeled and are to be maintained by the Home Owners Association.

Duane McNelly, Land Development Coordinator Department of Public Works

### CITY OF NORTH LAS VEGAS PLANNING COMMISSION AND CITY COUNCIL RECOMMENDATIONS / COMMENTS

FROM: CLARK COUNTY DEPARTMENT OF AVIATION

APPLICATION: FDP-000009-2021

PROJECT: NOBLE PEAK, 70 MFU

LOCATION: 139-04-201-021

MEETING DATE: SEPTEMBER 8, 2021, PLANNING COMMISSION AND

**CORRESPONDING OCTOBER 6, 2021, CITY COUNCIL** 

**MEETINGS** 

### **COMMENTS:**

The proposed development lies just outside the AE-60 (60-65 DNL) noise contour for North Las Vegas Airport (VGT), and is subject to significant aircraft noise and continuing over-flights. Future demand for air travel and airport operations is expected to increase significantly. Clark County intends to continue to upgrade VGT to meet future air traffic demand, and nighttime operations may and will continue to occur at VGT.

Applicant is advised that issuing a stand-alone noise disclosure statement to the purchaser or renter of each unit in the proposed development and to forward the completed and recorded noise disclosure statements to the Department of Aviation's Noise Office is strongly encouraged. Additionally, the Federal Aviation Administration will no longer approve remedial noise mitigation measures for incompatible development impacted by aircraft operations which was constructed after October 1, 1998, and funds will not be available in the future should the residents wish to have their buildings purchased or soundproofed.



main (702) 284-5300

**RAH2018** 

June 19, 2021

City of North Las Vegas Current Planning Department Staff 2250 Las Vegas Boulevard North North Las Vegas, NV 89032

Re: Nobie Peak – Final Development Plan

**Letter of Intent** 

(APN: 139-04-201-021)

Westwood Professional Services on behalf of our client, Richmond American Homes of Nevada, Inc., respectfully submits this letter of intent with an application for the Final Development Plan for the subject community.

### **Project Description**

The proposed development is a single-family attached residential community located near the northeast corner of the Craig Road and Clayton Street intersection, adjacent to Scott Robinson Blvd. The parcel is Lot 2 on the recorded Parcel Map 126-50, Assessor's Parcel Number 139-04-201-021. The parcel is ~6.5 acres with 70 lots, resulting in a density of ~10.8 du/ac. The community has an approved PUD (ZN-03-2021) which amended existing ordinance 3070.

Please find the enclosed Site Plan along with the Landscape Plan that details the proposed amenities for the Final Development Plan. Also enclosed are the Elevations for the architecture that will be used in this community. The homes will only be attached on one side which provides space for a private enclosed side yard on the other side of each property. This side yard will include its own private enclosed courtyard. There are two models which range in size from 1,510-1,520 SF. All homes will also include a porch in the front. The front of the homes will be articulated with stone veneer and other architectural enhancements.

The site plan included with the application shows the general layout of the project and the single access proposed from Scott Robinson Blvd. A secondary fire access will be provided. A typical lot width is ~25.8ft and all lots are larger than 2,000sqft. The proposed building setbacks which will be met for each lot are listed on the included site plan and below.

### Setbacks

Front – 12'
Porch – 10'
Side Yard – Building (Interior) – 5'
Side Yard – Building (Corner) – 5'
Attached Building to Building – 0' and 4'
Rear – Garage – 4'
Rear – Living – 4'

### **Open Space**

The interior open space provided exceeds 500/SF per lot. A single large centrally located common element is proposed containing 75% of the required interior open space. This central common element will include neighborhood park amenities. The remaining required interior open space will be distributed throughout the project. Additional landscaping is provided inside the community and along the perimeter but is not counted towards the total interior open space being provided. The pedestrian corridor in the middle of the site will have a landscape easement over the space between the porches for the Home Owners Association to maintain the landscape in this area. Finally, the single family homes are separated by ~42ft feet from front door to front door.

### **Benefits to the Neighborhood**

This project helps meet the demand for pedestrian friendly residential neighborhoods that target first time home buyers. These homes will bring additional population to area that will utilize the surrounding commercial centers while reducing the vacant lots.

### **Construction Timeline**

The entitlements were completed May of 2021 and the technical studies/design plans/final map will be finished in the 4th quarter of 2021. Grading is expected to start in September 2021 and offsite construction should be complete towards the end of 2022.

Please contact our office at 702-284-5300 if you have any questions or require additional information. Thank you for your consideration of this project.

Sincerely,

**WESTWOOD PROFESSIONAL SERVICES** 


Emily Hoy, P.E.

**Assistant Project Manager** 

mily Hoy

CC:

Angela Pinley, Richmond American Homes of Nevada, Inc. Jon Poll, Westwood Roxanne Leigh, Westwood

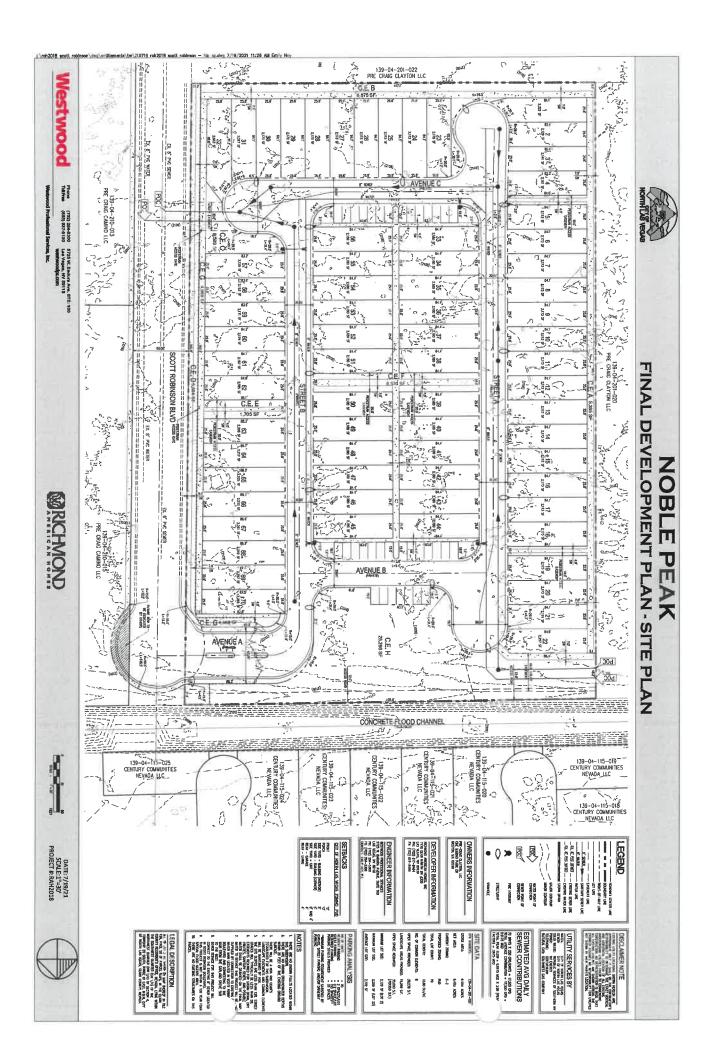

















# LANDSCAPE ARCHITECTURE: SUNSTATE STUDIOS

LANDSCAPE ARCHITECTURE
8. LAND PLANNING
93101 E.Craig Rd. N.Las Vegas, NV 89030
• www.sunstatestudios.com



Scott Robinson Blvd & Craig Rd N. Las Vegas, NV 89031

## DEVELOPER: **Richmond American Homes**

Las Vegas, NV 89139 7770 S. Dean Martin Drive, Suite 308

SHEET INDEX:	SHEET NO:	DRAWING NO:	SHEET TITLE:
	_	LA-0	Cover Sheet
	2	<b>-1</b>	Overall Plan
	ω4τυσ	<b>₽₽₽</b>	Construction Plan Construction Details Construction Details Construction Legend & Notes
	988	LA-6 LA-7	Planting Plan Planting Plan Planting Legend, Notes & Details
	12121	A-110	Overall Irrigation Plan Irrigation Plan Irrigation Plan Irrigation Plan Irrigation Legend & Notes Irrigation Legend & Notes
	14	F-13	Irrigation Details





Scale:	N.T.S.
Date drawn:	07-02-2021
Drawn by:	Ш
Designed by:	TT/JJ
Approved by:	TT
Project #:	800755
	Date drawn: Drawn by: Designed by: Approved by:

SHEET TITLE **Cover Sheet** 

		REVISIONS	
		Description	
	07-16-2021	100% REVIEW	
	08-03-2021	100%	
Н			


PROJECT NAME

Noble Peak

Streetscape & Common Area
Richmond American 7770 S. Dean Martin Drive, Suite 308 Las Vegas, NV 89139





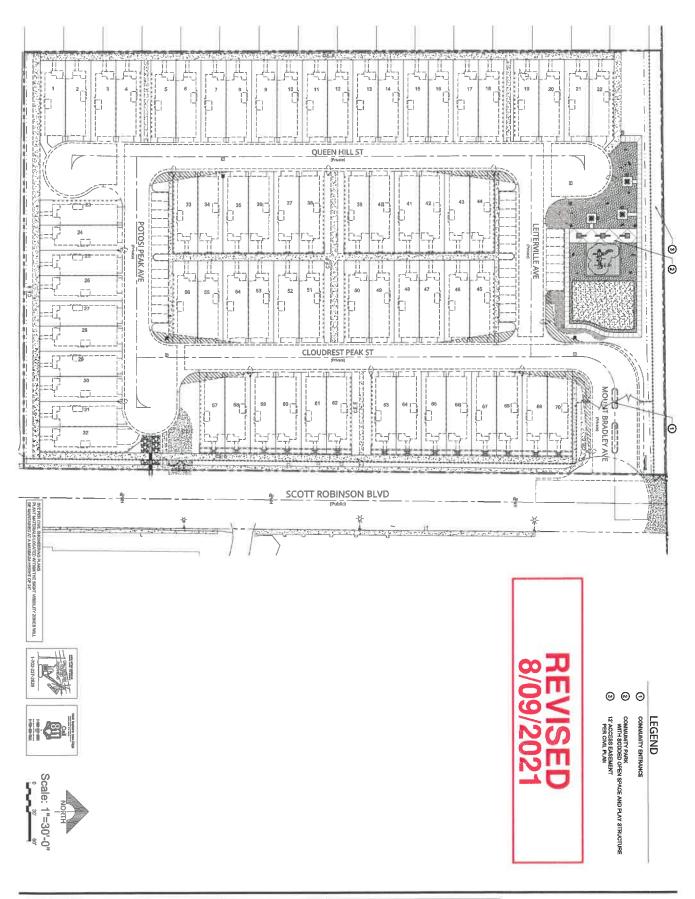

Scale: 1"30'-0"
Date drawn: 07-02-2021
Drawn by: IJ
Designed by: TT/IJ
Approved by: TT
Project #: 800755

Overall Plan

PROJECT NAME

Noble Peak

Streetscape & Common Area

Richmond American

7770 S. Dean Martin Drive, Suite 308 Las Vegas, NV 89139




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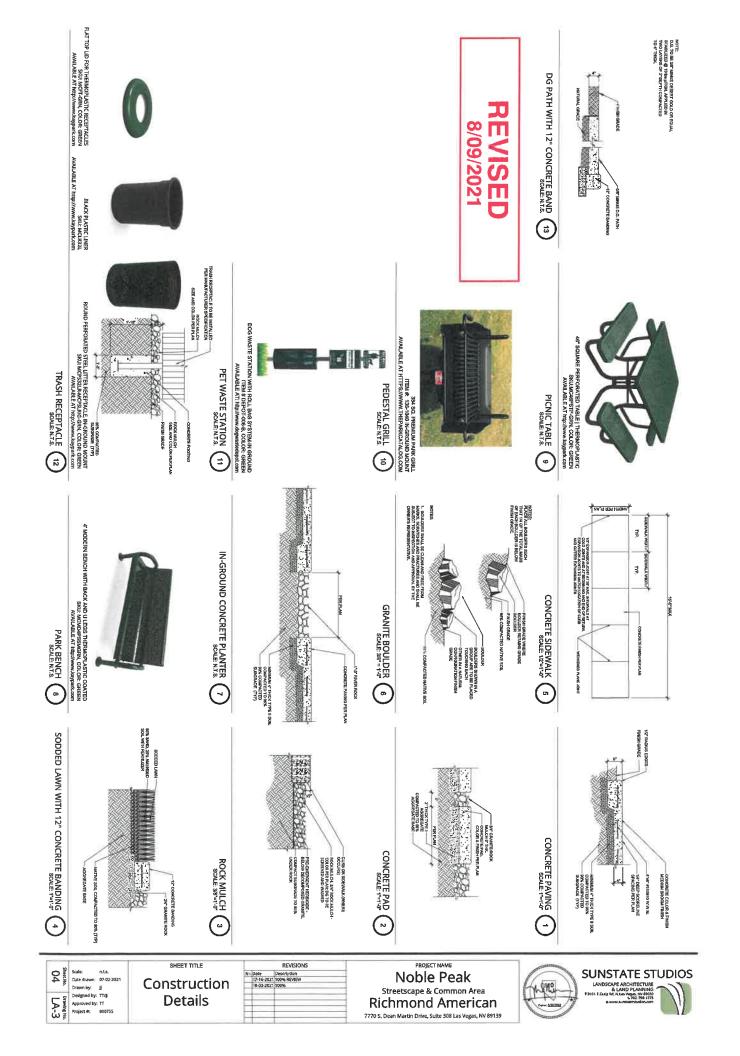
LANDSCAPE ARCHITECTURE


8. LAND PLANNING

13101 ECCEPT, M. LAND PLANNING

13



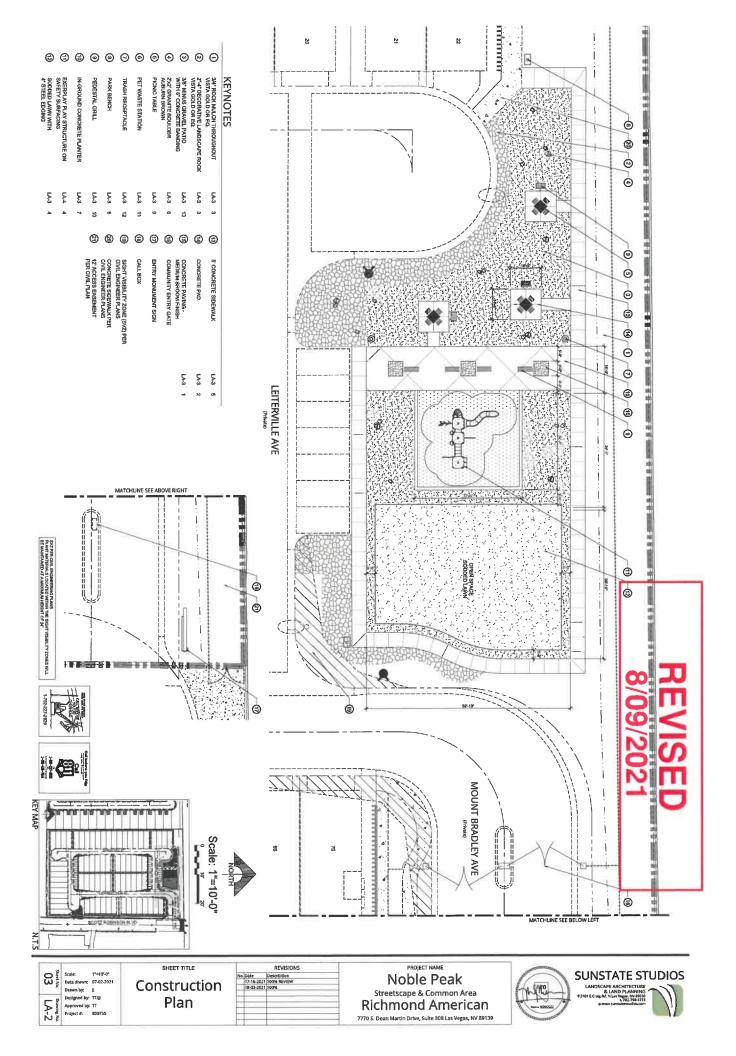

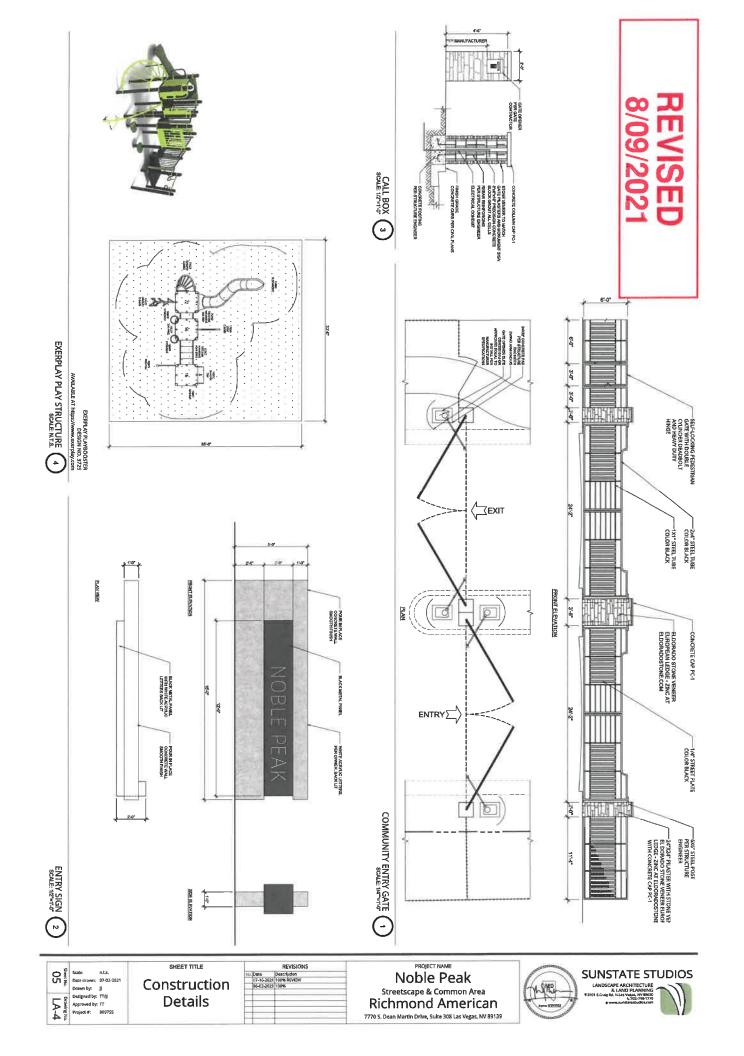

## GENERAL LANDSCAPE CONSTRUCTION NOTES

- THE CONTRACTOR SHALL PROTECT ALL EXISTING CONSTRUCTION FROM DAMAGE, AND SHALL REPAIR, AT 148 COST, ANY DAMAGE RESULTING FROM HIS OPERATIONS. CONTRACTORS ON THE JOB SHALL CARRY THE FOLLOWING INSURANCE: (1) WORKER'S COMPENSATION; (2) PUBLIC COMPRESIENS CENERAL LABILITY; AND (3) PROPERTY DAMAGE. IN AN EMERGENCY THREATENING THE LIFE, SAFETY, OR DISCRETION TO PREVENT SUCH LOSS OR INJURY.. ADJACENT WORK, THE CONTRACTOR IS HEREBY INSTRUCTED TO ACT AT HIS
- ARCHITECT FROM ANY CLAIMS ARISING OUT OF HIS OPERATIONS OR THE OPERATIONS OF ANY OF HIS SUBCONTRACTORS, MATERIAL SUPPLIERS OR AGENTS. THE CONTRACTOR AGREES TO HOLD HARMLESS THE OWNER AND LANDSCAPE
- DIMENSIONS ARE BASED ON PRELIMINARY MEASUREMENTS. CONTRACTOR TO VERIFY FIELD CONDITIONS AND MAKE ADJUSTMENTS IN ACCORDANCE WITH DESIGN INTENT. SHOWN IN DRAWINGS, ALTERNATE MATERIALS TO BE SPECIFIED IN SEPARATE BID CONTRACTOR'S BID SHALL REFLECT COST OF INSTALLATION OF MATERIALS AS
- CONTRACTOR SHALL OBYAIN ALL NECESSARY PERMITS FOR THE INSTALLATION OF ELECTRICAL, PLANISHING, IRRIGATION, CONCRETE, MASORY, AND LANDSCAPE MATERIAL FROM CITY OF LAS VEGAS BUILDING AND SAFETY DEPARTMENT, LY BAS (702) 229-6251
- NOTIFY THE LANDSCAPE ARCHITECT IMMEDIATELY OF ANY DISCREPANCIES BETWEEN CODES AND THE INFORMATION AND DESIGNS PRESENTED IN THESE DRAWINGS. ALL LOCAL MUNICIPAL, STATE, AND FEDERAL LAWS, RULES, AND REGULATIONS GOVERNING OR RELATING TO ANY PORTION OF THIS WORK ARE HEREBY INCORPORATED AND MADE A PART OF THESE SPECIFICATIONS AND THEIR PROVISIONS SHALL BE CARRIED OUT BY THE CONTRACTOR. THE CONTRACTOR
- SOILS REPORT AND FERTILIZATION RECOMMENDATIONS FOR REVIEW. CONTRACTOR SHALL SUPPLY OWNER AND LANDSCAPE ARCHITECT ONE COPY OF
- MOK THE CONTRACTOR SHALL OBTAIN AND REVIEW A SET OF THE APPROPRIATE ARCHITECTURAL, ELECTRICAL, AND CIVIL ENGINEERING PLANS PRIOR TO BEGINNING
- PRIOR TO THE START OF ANY WORK, A MEETING SHALL BE HELD WITH THE OWNER, LANDSCAPE ARCHITECT AND CONTRACTOR TO DISCUSS PROJECT PLANS AND SITE CONDITIONS
- THIS DOCUMENT SET, INCLUDING ALL PLAN SHEETS, NOTES, DETAILS AND SPECIFICATIONS SHALL BE UTILIZED BY THE CONTRACTOR PERFORMING INSTALLATION AS GENERAL GUIDELINES FOR THE PROJECT DESIGN INTENT.
  OLAMITIES SHOWN UN THIS DOCUMENT SET ARE ESTIMATES ONLY AND ARE NOT
  THENEFORE GUAGANTEED, THE CONTRACTOR SHALL SUPPLY ALL MATERIALS, LABOR NID EQUIPMENT IN ORDER COMPLETE PROJECT AS SPECIFIED IN THESE
- 5 CONTRACTOR SHALL COMPLY WITH ALL APPLICABLE BUILDING CODES AND WILL BE RESPONSIBLE FOR SCHEDULING AND ATTENDING ALL LY B&S INSPECTIONS ON BEHALF OF OWNER.
- **;** CONSTRUCTION DRAWINGS, SO THEY MAY BE CORRECTED PRIOR TO INSTALLATION THE CONTRACTOR SHALL NOTIFY THE LANDSCAPE ARCHITECT OF ANY DISCREPANCIES, WHICH OCCUR BETWEEN THE EXISTING CONDITIONS AND THE
- 12 THE CONTRACTOR SHALL TAKE NECESSARY PRECAUTIONARY MEASURES TO PROTECT EXISTING IMPROVEMENTS AND THE PUBLIC FROM DAMAGE THROUGHOUT THE CONSTRUCTION PROCESS
- 3 THE CONTRACTOR SHALL WARRANT ALL WORK AGAINST DEFECTIVE MATERIAL AND WORKMANSHIP AT NO ADDITIONAL COST TO THE OWNER. WORKMANSHIP FOR 90 DAYS FROM DATE OF FINAL APPROVAL, UNLESS OTHERWISE NOTED. THE CONTRACTOR AGREES TO REPLACE ANY DEFECTIVE MATERIAL AND/OR
- <u>‡</u> EXISTING SITE CONDITIONS AND THE DOCUMENT SET BASE INFORMATION HAVE BEEN PROVIDED BY THE PROJECT CIVIL ENGINEER, SEE CIVIL ENGINEERING DRAWINGS FOR ALL ROUGH GRADING AND DRAINAGE, SPOT ELEVATIONS ARE RELATIVE TO ADJACENT FINISHED GRADE AND SHOWN FOR REFERENCE ONLY, FIELD VERIFICATION OF ACTUAL ELEVATIONS MAY AFFECT INSTALLATION OF FLATWORK AND MASONRY.
- CONTRACTOR SHALL VERIFY LOCATION OF ALL EXISTING LIGHT POLES AND UNDERGROUND UTILITIES.
- ē OWNER SHALL APPROVE ALL MATERIALS PRIOR TO ORDERING. SUBMIT FINISH
- SAMPLES OF FLATWORK FOR OWNER APPROVAL PRIOR TO ORDERING.

CONTRACTOR SHALL SHIELD EXISTING WORK WITH VISQUEEN TO PREVENT

17.

<u>,</u> ALL WRITTEN DIMENSIONS ON PLANS SHALL TAKE PRECEDENCE OVER SCALED

- CONCRETE NOTES

  1. CONGRETE SHALL HAVE A MINIMUM COMPRESSIVE STRENGTH AT 28

  1. CONGRETE SHALL HAVE A MINIMUM COMPRESSIVE STRENGTH AT 28

  1. CONGRETE SHALL BE TYPE 1. FINISH MEDIUM BROOM
  FINISH AND COLOR SHALL BE TAITURAL GREY UNLESS OTHERWISE
- PROVIDE 12" SQUARE SAMPLE POUR FOR APPROVAL PRIOR TO INSTALLATION.
- REINFORCING SHALL COMPLY WITH ASTM A615, GRADE 40.
  CONTRACTOR SHALL INSTALL FULL-DEPTH EXPANSION JOINTS AND ADDITIONAL JOINTS WHERE NECESSARY TO CONTROL CONCRETE SCORE JOINTS AS SHOWN ON PLANS AND DETAILS, AND ADD
- CRACKING.

  ALL CONCRETE SLABS SHALL HAVE A MINIMUM 4" TYPE II LAYER SUBGRADE AND WIRE MESH PER CONSTRUCTION DETAILS.
- EQUAL TO WIDTH OF WALKS (I.E. 38"O.C. IN 38" WIDE WALK), SCORE MARKS SHALL NOT BE LESS THAN 3"4"O.C. OR MORE THAN 3"5"O.C. PROVIDE QUICK JOHN'S AT 3"4"O.C., FOR 3"4" WIDE WALKS, 12"4"O.C. FOR 4-0" WIDE WALKS, AND 15"4"O.C. FOR 5-0" WIDE WALKS, ALL EXPANSION JOINTS SHALL NOT EXCEED 1/2 WIDE AND SHALL BE SEALED WITH "DECK O MASTIC SEAL" CONTRACTOR SHALL PROVIDE SCORE MARKS IN CONCRETE WALKS

- MASONRY NOTES
  8. ALL STUCCO WALLS SHALL BE WATER SEALED WITHIN 30 DAYS OF STUCCO COLOR. ALL STUCCO SHALL MATCH ARCHITECTURE IN FINISH. EXCEPT AS NOTED.
  ALL RETAINING WALLS SHALL BE PLANTABLE
- **;** PAYER NOTES
  10. REFER TO CIVIL PLANS FOR INSTALLATION OF ASPHALT SUBBASE IN STREET AND CUL-DE-SAC. ADD 1\* WASHED CONCRETE SAND OVER TOP OF TYPE II BASE. <u>DO NOT COMPACT SAND.</u> SAND IS TO BE SCREENED ON, NOT COMPACTED. FOR SCREENING, USE A 1\* ROUND PVC PIPE ON EACH SIDE OF STREET AS A GUIDE. USE ANOTHER PVC PIPE TO LEVEL THE SAND BY DRAGGING IT ACROSS THE PVC GUIDE PIPES.
- 12. 13. SET PAVERS BY HAND.

  AFTER THE PAVERS HAVE BEEN SET, USE A TAPPER TO FORCE THE TO LOCK THE PAVERS INTO PLACE SAND THROUGH THE CRACKS BETWEEN THE PAVERS. THIS WILL HELP
- £ 55, SWEEP EXCESS SAND INTO JOINTS.
  REPEAT TAPPER AND SWEEPING PROCESS.

- HARDSCAPE NOTES

  1. INSTALER SHALL ENOUT AND VERIFY ALL HARDSCAPE ELEMENTS

  1. INSTALER SHALL CONTACT LAS OWNER REP. SHOULD ANY
  INSTALER SHALL CONTACT LAS OWNER REP. SHOULD ANY
  INSTALER SHALL CONTACT LAS OWNER REP. SHOULD ANY
  DISCREPANCIES EXIST. INSTALER SHALL SUBMIT IN WRITING
  SUGGESTED MODIFICATION AND RECEIVE TRANSMITTED RECORD OF
  APPROVAL FROM OWNER'S AUTHORIZED REPRESENTATIVE PRIOR TO COMMENCEMENT OF CONSTRUCTION.
- DIMENSIONS SHOWN ON THIS PLAN ARE BASED ON THE DOCUMENTS SUBMIT IN WRITING SUGGESTED MODIFICATION & RECEIVE TRANSMITTED RECORD OF APPROVAL FROM LA & OWNER REP PRIOR TO SUBMITTED BY THE CE. INSTALLER SHALL CONTACT THE LA & OWNER REP SHOULD ANY DISCREPANCIES OCCUR. LA & OWNER REP SHALL COMMENCEMENT OF ANY FIELD REVISIONS.
- REFER TO CONSTRUCTION DOCUMENTS PREPARED BY THE CE FOR ALL INFORMATION REGARDING HORIZONTAL & VERTICAL CONTROL
- INSTALLER SHALL BE RESPONSIBLE TO HAVE ALL STRUCTURES REPRESENTED IN THE CO SET & REVIEWED BY A REGISTERED STRUCTURAL ENGINEER PRIOR TO CONSTRUCTION UNLESS OTHERWISE NOTED (U.M.O.).
- FOOTINGS, WALLS AND FENCES SHALL BE PLACED OUTSIDE OF THE PUBLIC RIGHT-OF-WAY.
- INSTALLER SHALL HAVE SIDEWALKS SURVEYED AND STAKED FOR REVIEW BY LA PRIOR TO INSTALLATION. INSTALLER SHALL NOTIFY LANDSCAPE ARCHITECT WITHIN 48 HOURS IN ADVANCE FOR SITE
- UNLESS OTHERWISE NOTED (U.N.O.) IN CD SET OR NOTED IN DETAILS, SIDEWALKS SHALL BE 5'-0" IN WIDTH 4" THICK WI 2500 PSI CONCRETE ON COMPACTED BASE PER SITE SOILS REPORT W/ CONSTRUCTION JOINTS SIDEWALKS SHALL HAVE A MEDIUM BROOM, NON-SKID FINISH PERPENDICULAR TO DIRECTION OF TRAVEL WITH 1/2" RADIUS TOOLED AT 5'-0" ON CENTER & EXPANSION JOINTS AT 20'-0" ON CENTER.
- RADIUS AT SIDEWALK INTERSECTIONS SHALL BE 5'-0" TYPICAL (TYP.)
- INSTALLER SHALL PREPARE A 4'X4' SAMPLE PANEL FOR EACH TYPE OF HARDSCAPE MATERIAL AS SPECIFIED IN CD SET FOR APPROVAL BY THE LA & OWNER REP PRIOR TO CONSTRUCTION.
- SPILLS ON FINISHED HARDSCAPE INSTALLER IS RESPONSIBLE FOR IMMEDIATE REMOVAL OF STAINS AND

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= INSTALLER FOR PROTECTION OF FINISHED WORK UNTIL PROJECT ACCEPTANCE BY OWNER REP

### PARK BENCH DOG WASTE STATION TRASH RECEPTACLE PEDESTAL CHILL **COLOR & SITE FURNISHING** 384 SQ. PREMIUM PARK GRILL 46" SQUARE PERSORATED TABLE - GREEN A MODERN BENCH WITH BACK- GREEN DEPOT-008-B IN-GROUND MOUNT STEEL RECEPTACLE - GREEN WWW.THEPARKCOTALOG.COM WWW.DOGWASTEDEPOT.COM WWW.KAYPARKCOM QUANTITY

2"-4" DECORATIVE LANDSCAPE ROCK: VISTA GOLD OR EQ. 3/4" GRANITE ROCK MULCH -VISTA GOLD OR EQ. MATERIAL LEGEND

BERMUDA GRASS 3/8" MINUS GRAVEL VISTA GOLD OR EQ

3,292 SQFT

## 8/09/2021


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2'X" LANDSCAPE BOULDERS-AUBURN BROWN SAFETY SURFACING

> 20 EA 1,155 SQFT

Scale: n.t.s.
Date drawn: 07-02-2021
Drawn by: JJ
Designed by: TT/JJ
Approved by: TT
Project 4: 800755


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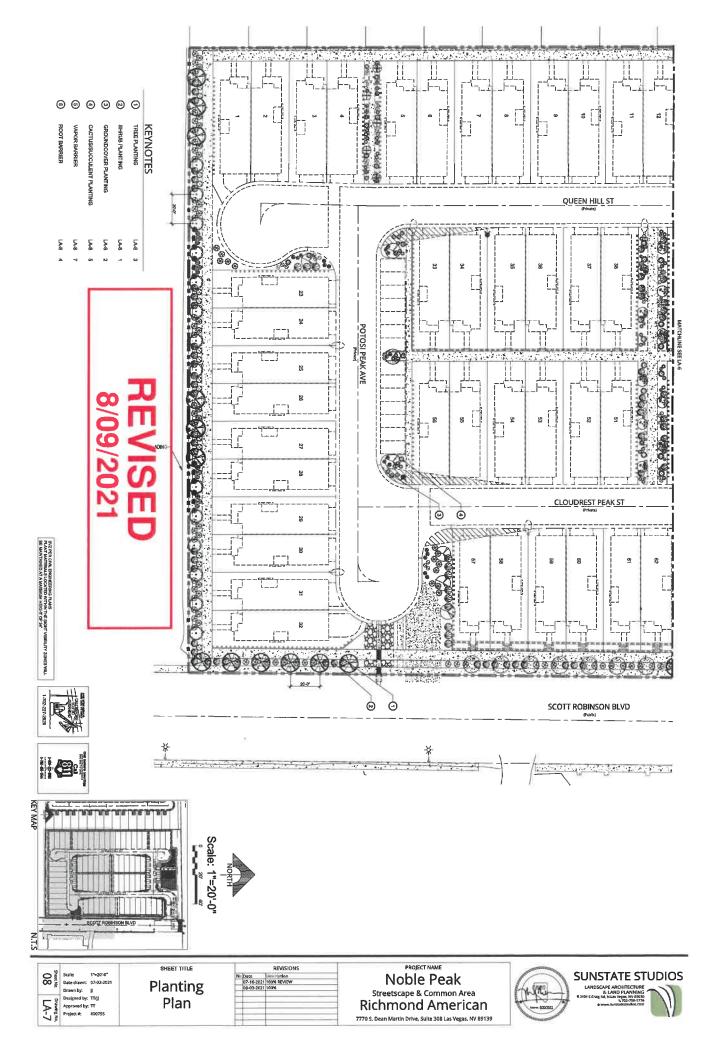



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		REVISIONS	
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PROJECT NAME Noble Peak Streetscape & Common Area Richmond American 7770 S. Dean Martin Drive, Suite 308 Las Vegas, NV 89139

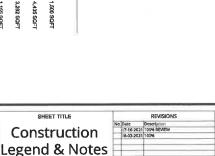






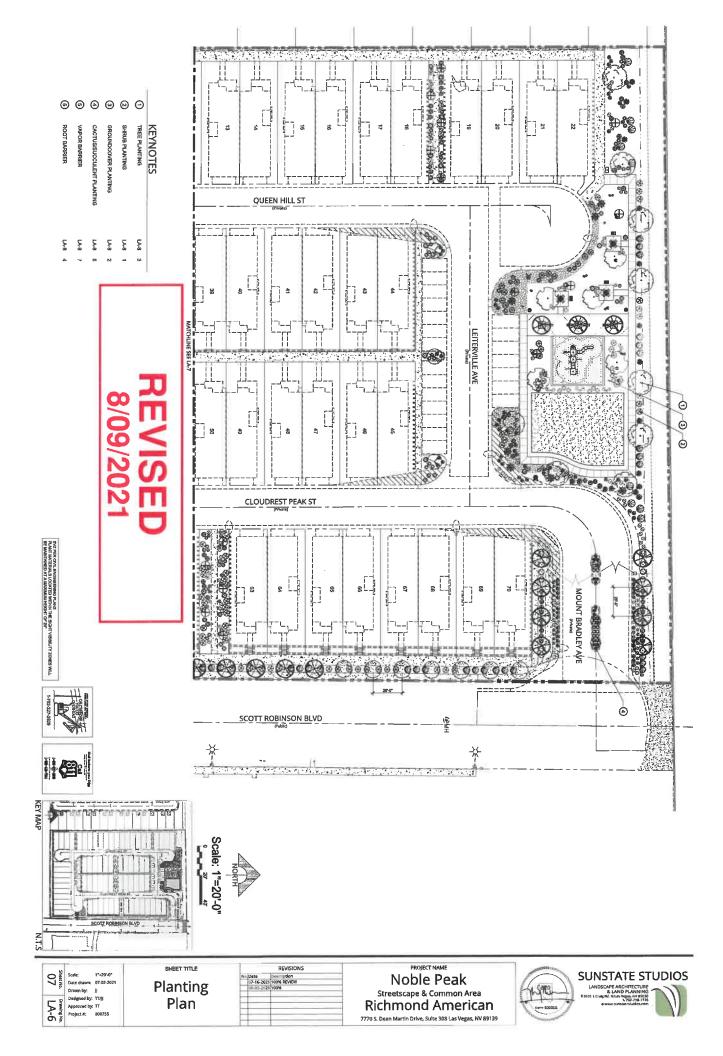
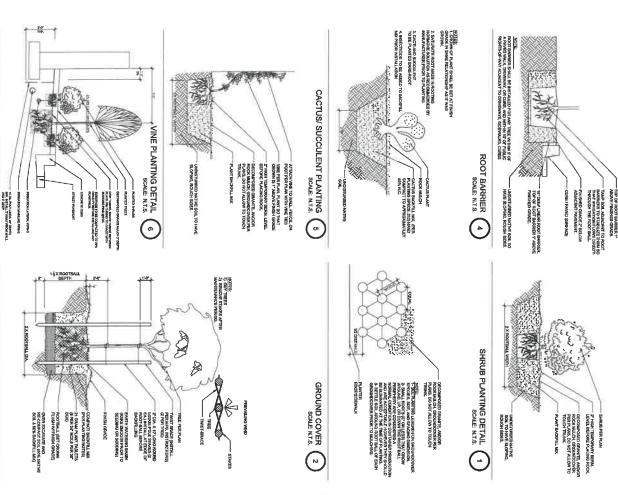
## PLANTING LEGEND

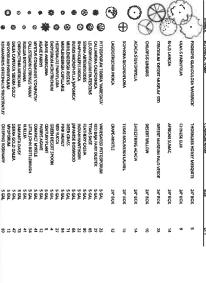

### REV S

CONTRACTOR TO REVIEW PROJECT GEOTECH REPORT PRIOR BIDDING AND INSTALLATION.

GENERAL LANDSCAPE PLANTING NOTES

- CONTRACTOR TO INSTALL LANDSCAPE, HARDSCAPE AND IRRIGATION PER PROJECT GEOTECH REPORT'S RECOMMENDATIONS.
- PLANT QUANTITIES ARE PROVIDED FOR THE CONVENIENCE OF THE OWNER. THE LANDSCAPE CONTRACTOR IS RESPONSIBLE FOR FOR PLANT QUANTITIES AS THEY APPEAR ON THE PLAN.
- ALL TREES PLANTED WITHIN FIVE (6) FEET OF HARDSCAPE SHALL RECEIVE DEEP ROOT BARRIERS
- ALL TIREE AS ENRUB MATERIAL SPECIFED MUST METE THE TIME OF DUDUSTRY SPECIFICATIONS OF RITHE CONTINUES SEE RIDICATED. IF CONTRACTOR CANNOT LOCATE METELLA OF ACCEPTABLE SEE AT THE TIME OF DUDUSTRIALATION, CONSTRUCTON MANAGER SIZE RIDICATED. METELLA DE SECIES SUBSTITUTION OF PLANT MATERIAL WITHOUT PRIOR APPROVAL OF CONSTRUCTION MANAGER IS NOT PERSHISSBLE.
- ALL PLANTS SHALL BE INSTALLED PER PLANTING SETALS PROVIDED IN THESE PLAK. PLANT MATERIAL SHALL NOT BE ROOT BOUND. FIVE GALLON PLANTS AND LAGGER SHALL BE INSTALLED PER PLANTIANNERS FOR A MINIMAIM OF 8 MONTHS AND MAXIMAIM OF TWO YEARS. PLANTS SHALL EXHIBIT HEALTHY GROWTH AND BE PREE OF DISEASES AND PESTS. SHRUB AREAS SHALL RECEIVE 2" MINIMUM THICK LAYER OF DECORATIVE CRUSHED ROCK, COLOR TO BE DETERMINED BY LANDSCAPE ARCHITECT.

TREE LOCATIONS SHOWN ON PLANS MAY REQUIRE AJUSTILENTS IN THE FIELD INVENERE PEASURE. TREES SHOULD BE PLAYTED A MINIMUM OF TEN (19) FEET FROM ALL UNDERGREVOND UTILITIES, STREETLICHTS, MYDANTS, AND OUT OF DRAINGE FLOW LINES, VERIFY WITH SOUTHERN NEWHON PRACTICES, SPOULD THIS NOT BE POSSBUE, CONTACT THE CONSTRUCTION MANAGER FOR DECISION ON PLACEMENT.

- 9. PLANT BACKFILL SHALL BE 75% REJECT SAND AND 25% MULCH, SOIL TEST MAY BE RECOMMENDED PRIOR TO PLANTING.
- 10. STAKE ALL TREES PER DETAIL. REMOVE NURSERY STAKES AND TIES FROM ALL CONTAINER STOCK.
- PRIDR TO THE START OF ANY WORK, A MEETING SHALL BE HELD WITH THE DWINER, CONSTRUCTION MANAGER AND CONTRACTOR TO DISCUSS PROJECT GOAL, PLANS AND SITE CONDITIONS.
- 13. VERIFY ALL DIMENSIONS AND EXISTING CONDITIONS ON THE SITE PRIOR TO ISSUANCE OF ANY BIDS, OR PROCEEDING WITH ANY CONSTRUCTION. THE CONTRACTOR SHALL NOTIFY THE CONSTRUCTION MANAGER OF ANY DISCREPANCIES, WHICH OCCUR BETWEEN THE EXISTING CONDITIONS AND THE CONSTRUCTION DRAWINGS, SO THEY MAY BE CORRECTED PRIOR TO INSTALLATION, CONSTRUCTION MANAGER SHALL CONTACT LANDSCAPE ARCHITECT PRIOR TO PLANTING OF NEW PLANT MATERIAL AS DESIGNATED ON PLAN, CONTRACTOR SHALL HAVE ALL PLANT SPOTTED ON SITE PER PLAN TO BE REVIEWED AND APPROVED BY THE CONSTRUCTION MANAGER PRIOR TO DIGGING OR BACKFILLING OF PLANTING PITS.

- THE CONTRACTOR SHALL CARRY OUT THE FULL INTENT OF THE PLANS, DETAILS AND SPECIFICATIONS, USING WORKMANSHIP IN A MANNER IN ACCORDANCE WITH THE BEST METHODS OF THE TRADE.
- THE CONTRACTOR SHALL NOT MAKE ANY CHANGES OR DEVATIONS FROM THE FINAL DRAWINGS WITHOUT THE PERMISSION OF THE CONSTRUCTION MANAGER.
- THE CONTRACTOR IS TO PROVIDE CONTINUOUS INSPECTIONS DURING CONSTRUCTION AND SHALL COORDINATE AND BE RESPONSIBLE FOR THE ACTIONS OF HIS OR HER SUBCONTRACTORS.
- THE CONTRACTOR SHALL WARRANT ALL WORK AGAINST DETECTIVE MATERIAL AND WORKMANSHIP FOR 30 DAYS FROM DATE OF FINAL APPROVIAL UNLESS OTHERWISE NOTED. THE CONTRACTOR AGREES TO REPLACE ANY DEFECTIVE MATERIAL AND/OR WORKMANSHIP AT NO ADDITIONAL COST TO THE OWNER. THE CONTRACTOR SHALL NOTIFY THE CONSTRUCTION MANAGER A MINIMUM OF 46 HOURS PRIOR TO THE GOVERNING AUTHORITY'S FINAL INSPECTION AND ANY OTHER WARRANTED SITE VISITS.

Scale: n.t.s
Date drawn: 07-02-2021
Drawn by: JJ
Designed by: TT/JJ
Approved by: TT
Project #: 800755

909

LA-8

MATURE HEIGHT OF ALL PLANTING MATERIAL WITHIN VISIBILITY TRIANGLE SHALL NOT EXCEED 24". HEIGHT OF ALL SHRUBS AND GROUNDOOVER WITHIN THE VISIBILITY TRIANGLE TO BE MAINTAINED AND TRIMMED LOWER THAN 24".

VAPOR BARRIER (7)

TREE PLANTING DETAIL (3)

SHEET TITLE		REVISIONS	PROJECT NAME
<b>5</b> 1	No Date 07-16-2021	Description 100% REVIEW	Noble Pea
Planting Legend,	08-03-2021		Streetscape & Commor
Notes & Details			Richmond Ame
			7770 S, Dean Martin Drive, Suite 308 Las V







7	_		
	10	Scale: Date drawn:	1*#30"-0" 07-02-2021
	- 6	Drawn by:	J
-1	0	Designed by:	TT/JJ
П	¥ \$	Approved by:	TT
I	1-9	Project #:	600755


Overall Irrigation Plan




PROJECT NAME **Noble Peak** Streetscape & Common Area Richmond American 7770 S. Dean Martin Drive, Suite 308 Las Vegas, NV 89139



**SUNSTATE STUDIOS** 

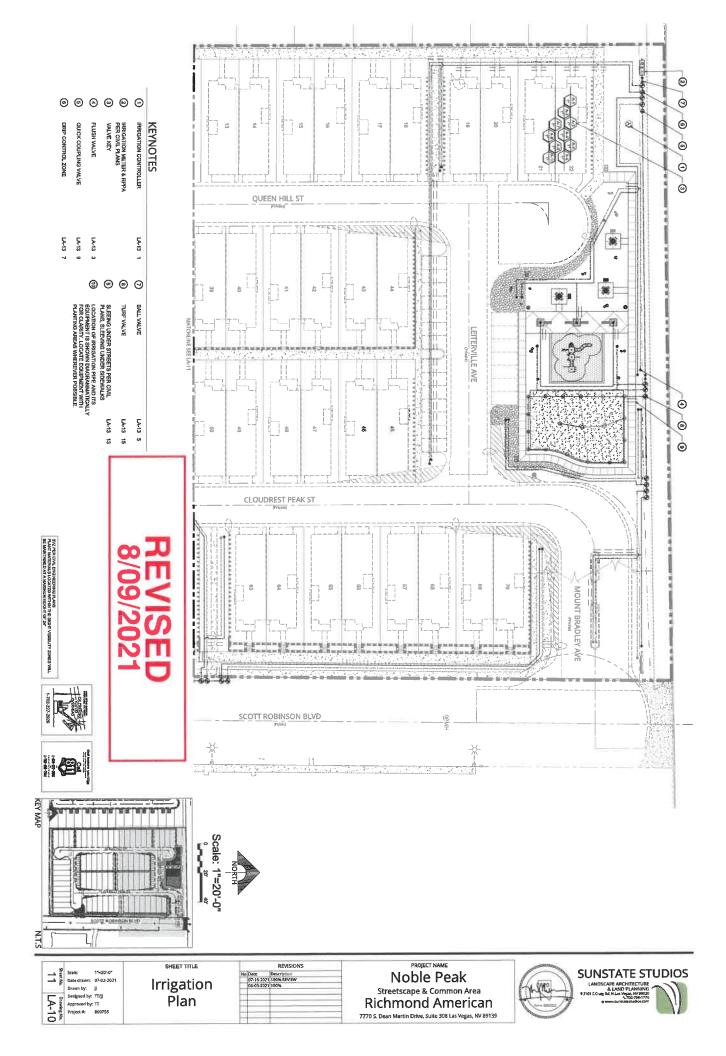

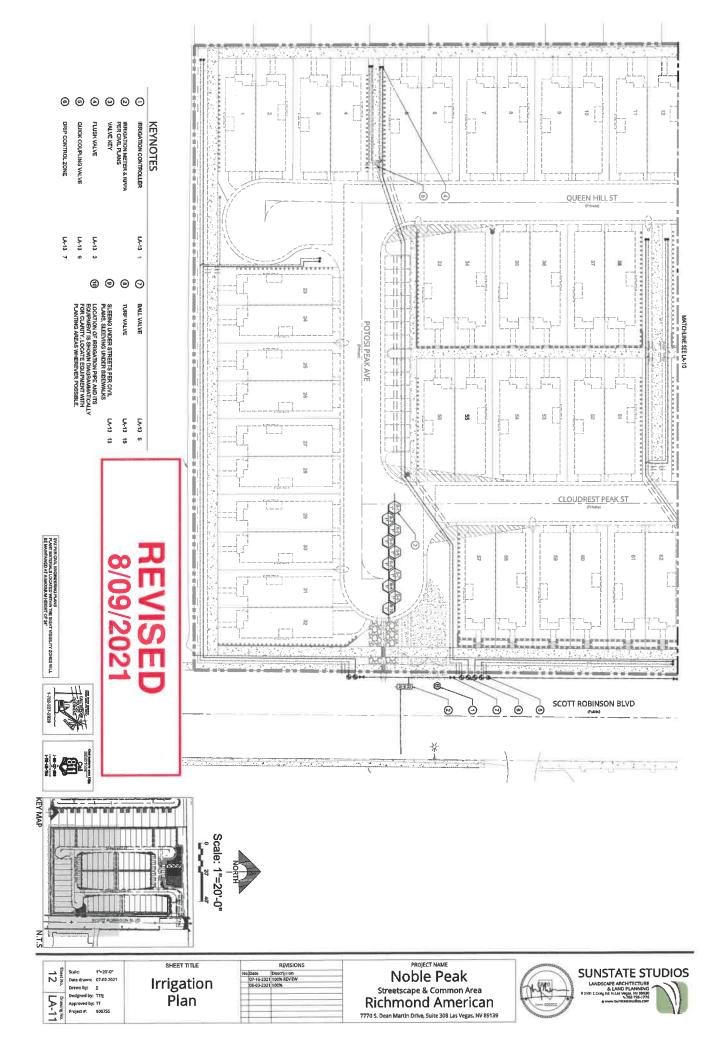

### GENERAL LANDSCAPE IRRIGATION NOTES

- . ALL LOCAL MUNICIPAL AND STATE LAWS RILLES AND REGULATIONS GOVERNING OR RELATING TO ANY PORTION OF THIS WORK, ARE HEREBY INCORPORATED INTO AND MADE A PART OF THESE SPECIFICATIONS AND THEIR PROVISIONS SHALL BE CARRIED OUT BY THE CONTRACTOR.
- THE CONTRACTOR SHALL VEREY THE LOCATIONS OF ALL EXISTING UTILITIES.

  STRUCTURES AND SERVICES BEFORE COMMENDING MORE, THE LOCATIONS OF
  UTILITIES, STRUCTURES AND SERVICES BYOMIN IN TRESE PLANS ARE APPROXIMATE
  ONLY. ANY DESCRIPTIONES SET TIVES THESE PLANS ACTUAL HELD CONUTIONS
  SHALL BE REPORTED TO THE OWNERS REPRESENTATIVE.
- 2. CONTRACTOR TO VERRY PRESSURE CHASTE AND NOTIFY, ANDSCAPE AGENTECT OR OWNERS AUTHORIZED REPRESSURE OF A THRIVE OF ANY DESCREPANCES PRICE TO WISTALATION OR ORDERING OF MATERIALS IF CONTRACTOR FALS TO NOTIFY THE PROPER WAIT THE CONTRACTOR SHALL SE FRANCALLY DESPONDENT OR ALL MECCESSARY SYSTEM, ALTERATIONS REQUIRED TO CACILITATE AN EFFICIENT AND OPENATIONAL SYSTEM, THIS BRIGATION SYSTEM REQUIRED A MINIMAM OF 65 TO 76 781 WAITEM FREIGHT AND THE PRESSURE AT WAITEM RETURN SYSTEM REQUIRES A MINIMAM OF 65 TO 76 781 WAITEM FREIGHT.
- I, THE CONTRACTOR SHALL OBTAIN THE PERTINENT ENGINEERING OR ARCHITECTURAL PLANS BEFORE BEGINNING WORK.
- 6, THIS DESIGN IS DIAGRAMMATIC. ALL ECUIPMENT SHOWN, IN PANED ATEAS IS FOR DESIGN CLARITY ONLY AND IS TO BE INSTIALED WITHIN PLANTING ASSAIS. THE COMPRACTION SHALL BE RESPONSIBLE FOR FULL RENGATION COVERAGE OF ALL PLANT MATERIAL INCLIDING TUPE. SINGLE LINES SHOWN MAY REPRESENT MULTIPEL LINES OF OUNDLITT. PAC WATER LINES OR PVC SLEEVES DEPENDING ON INSTIALATION DESIGN REQUIREMENTS.
- 8, DO NOT WILLFULLY INSTALL ANY EQUIPMENT AS SHOWN ON THE PLANS WHEN IT IS OBMOUS AN THE FIELD THAN UNKNOWN COMMITONS DOST THAN YEER OF EVIDENT AT THE TIME THESE PLANS WEER EREPARED, ANY SUCH CONMITIONS SHALL BE REQUEIT OF THE ATTENTION OF THE OWNER'S REPRESENTATIVE PRIOR TO ANY WORK OR THE IEROATION CONTROLORS SHALL ASSUME, ALL RESPONSIBILITY FOR ANY FIELD CHANGES DEEMED NECESSARY BY THE OWNER.
- . INSTALL ALL EQUIPMENT AS SHOWN IN THE DETAILS AND SPECIFICATIONS.
  CONTRACTOR SHALL BE RESPONSIBLE TO COMPLY WITH LOCAL CITY, COUNTY AND STATE REQUIREMENTS FOR BOTH EQUIPMENT AND NOTALLATION.
- A. ACTUAL LOCATION FOR THE INSTALLATION OF THE BACKFLOW PREVENTER AND THE AUTOMATIC CONTROLLER IS TO BE DETERMINED IN THE FIELD BY THE OWNERS AUTHORIZED REPRESENTATIVE. 8. LOCATION OF EXISTING ELECTRICAL AND WATER CONNECTIONS (POC) MAY ALTER LAYOUT SHOWN FIELD VERIFICATION OF EXISTING UTILITIES REQUIRED PRIOR TO
- CONTRACTOR IS TO PROVIDE AN ADDITIONAL PILOT WIRE TO THE END OF THE MAINLINE RUN IN TWO DIRECTIONS FROM THE CONTROLLER.
- IT. ALL PIER UNDER RAVED AGEAS TO BE INSTALLED IN A SCH 4/0 SLEENE WINCE THE DIMMETER OF THE PIEPE CAMEID, ALL WRIGE UNDER PINCE DES INSTALLED IN A SCH, 4/0 SLEENE THE SIZE REGUIRED TO EASILY PULL WRIE. THROUGH, ALL SLEENES OF DE RIVAL AND AND DET ALL SMETCH AS SHOWN ON THE SLEENING DETAILS. SLEENES TO SCHOOL AFLESH, TO SHE THE ADDITION AT LESH TO PAST THE EDGE OF THE PLAYING.
- 12. ALL QUICK COUPLET VALVES TO BE NISTALED IN SHRIJB OR GROUND COVER AREAS WHERE POSSIBLE. ALL QUICK COUPLER WALVES TO BE INSTALLED AS SHOWN ON THE INSTALLATION DETAILS. INSTALLATION DETAILS.
- 13. ALL VALVES SHALL NOT EXCEED MANUFACTURES SPECIFICATIONS.
- 16. SUPPLY THE FOLLOWING MATERIAL TO THE OWNER: TWO WRENCHES AND VALVE SUPPLIED, TWO KET'S FOR EACH OF THE COMITION. TWO VALVE BOX KET'S. 14. VALVE BOXES TO BE BRANDED WITH CONTROLLER AND STATION NUMBER
- 16. FLUSH CAPS SHALL BE PLACED IN A VALVE BOX AT THE END OF ALL LATERALS.
- TIT. THE CONTRACTOR SHALL BE RESPONSIBLE FOR CUTTING AND PATCHING OF ASPHALT AND CONCRETE AS REQUIRED FOR SLEEVE INSTALLATION ACCORDING TO THE IRRIGATION SCHEDULE.
- FLUSHING OF ALL LINES PRIOR TO INSTALLATION OF SPRINKLERS AND EMITTERS IS REQUIRED.
- 18 COMPROLLER TO BE INSTALLED AS PER MANUFACTURERS SPECIFICATIONS.

  COMPROLLER SIZE AND QUAMITIES TO BE DETERMINED BY THE YALVE REQUIREMENTS.

  AND POINT OF COMINGOTIONS ALL ELECTRICAL COMINGOTIONS SHALL BE MADE AT THE

  REMOIT ECONTROL WALVE BOSES, COMPROLLER REPLICASSIVES AND VALVE BOSETS.

  SPECIFICALLY FOR BECTRICAL, COMMECTIONS, THE CONTROLLER WIRES THAT THE 129

  YOU'S COURSE LOCATION TO AUTOMATIC COMPROLLER, CONTROLLER WIRES THAT ARE

  DIRECT SURFIES SHALL BE 8'M, OR BETTER, BUNGLED ON WADAPPED, ANNIMAN OF

  EMERY THE STALL SHALL BE SHOULD BE STALL SHALL BY THE SHALL BE SHALL BY THE SHALL BY THE
- 20. ALL HEADS AGE TO BE INSTALLED WITH THE NOZZLE, SCREEN AND ARCS SHOWN ON THE PLANS, ALL HEADS AGE TO BE ADJUSTED TO REVENT OVERSEPRAY ONTO BULDINGS, WILLS, FENCES AND HEADSCAPE. THIS INCLUDES, BUT NOT LIMITED TO, ADJUSTINENT OF PRESSURE COMPENSATION SCREEN, REPLACEMENT OF PRESSURE COMPENSATION SCREEN, REPLACEMENT OF PROZECTS WITH MODE APPROPRIATE PADIUS UNITS AND THE REPLACEMENT OF PROZECTS WITH ADJUSTABLE ARC UNITS.
- BACKFLOW DEVICES SHALL BE A MINIMUM OF TWO (2) FEET FROM THE WATER METER AND BE THE SAMESIZE AS THE METER SERVICE LINE.
- 2. PRIOR TO PUCING AW REGIGATION SYSTEM IN SERVICE, AN NEI/ADA CERTIFED BACKFLOW DEVICE TESTERS SHALL TEST THE ACKFLOW PREVENTION EDRICE AND GIVE A COPY OF THE PASSED TEST RESULTS TO THE PROPERIOR GOVERNIOR AGENCIES. AFTER NITIAL TESTING, ALL BACKFLOW DEVICES SHALL BE TESTED ANNUALLY.
- ALL LINES LAYOUTS ARE SCHEMATIC: CONTRACTOR TO BID ON ACTUAL NEEDED QUANTITY/LENGTH.

## GENERAL LANDSCAPE IRRIGATION MAINTENANCE NOTES:

- CONTRACTOR IS RESPONSIBLE TO PROGRAM CONTROLLERS IN ORDER TO APPLY ADEQUATE MOST PROFILE TO MAINTAIN VIGOROUS PLANT GROWTH IN LANDSCAPE AREAS, OR AS REQUIRED BY THE LANDSCAPE ARCHITECT DUE TO TEMPERATURE DIFFERENCES.
- CONTRACTOR SHALL BE RESPONSIBLE FOR TURNING OFF CONTROLLERS DURING INCLEMENT WEATHER.
- CONTRACTOR SMALL BE RESPONSIBLE TO REGULARLY INSPECT AND EXAMINE THE SPRINKLER SYSTEM WITH RESPECT TO PROPER FUNCTION AND MUST CLEM HENDS TO ASSURE PROPER FUNCTION.
- THE CONTRACTOR SHALL INFORM THE OWNER IMMEDIATELY OF ANY PARTS WHICH HEED REPAIRS OR REPLACEMENT RESULTING FROM THEFT OR VIOLAUSIA REPLACEMENT COSTS DUE TO VANDALISM OR THEFT WILL BE BOTANE BY THE OWNER.
- THE CONTRACTOR SHALL BE RESPONSIBLE FOR REPLACEMENT COSTS DUE TO DAMAGE RESULTING FROM HIS OPERATIONS.
- CONTRACTOR SHALL DESCORM ALL REPAIRS, REPLACEMENTS, STRAIGHTENING, RAISING, ETC., OF THE SPRINACER SYSTEM AS IS APPLICABLE TO RISERS AND SPRINACER HOUSED, MY REPAIR OR REPLACEMENT MUST CONFORM TO TYPE AND KIND CURRENTLY BEING USED, ANY DEVIATION MUST BE APPROVED BY THE OWNER AND LANDSCAPE ARCHITECT.
- ALL PAVED AREAS SHALL BE KEPT FREE OF TRASH AND DEBRIS AND WILL BE SWEPT, VACUUMED, WASHED, OTHERWISE CLEANED EACH VISIT TO ASSURE A CLEAN AND NEAT APPEARANCE.

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PROTECT BUILDINGS FROM WATER SPLASHING AND SOIL STAINING.

### DRIP SYSTEM NOTES:

ALL LATERAL LINES FOR RISE SYSTEMS HALL BE PUC AS SHOWN IN THE LEGERD, POLY TUBING SHALL BE CONNECTED TO THE PUC LATERAL LINES IN LOCATIONS ALONG THE LATERAL LINE ROUTE IN QUANTITIES AND LOCATIONS REQUIRED BY THE PLANT GROUPS AND THE MAXIMUM POLY TUBING RUN AS INDICATED IN THE DETAILS.

- CONNECT POLY TURNO TO PVO AS PER DETALS AND ROUTE TURNO THROUGH PLANT MASSES. INSERT IDEE BAITTERS MYTO TURNO AS CODES AS POSSIBLE TO PLANT MATERIALS, ROUTE 14" TURNO FROM EMITTER TO PLANT, MAX. DISTANCE 8 FT. STAVE ALL DRIP TURNO TO GRADE USING WITE STAVES. COVER ALL DRIP TURNO COMPLETELY WITH MALLO SPECIFIED OF LANDS-EVER FLANS.
- AT ALL RAISED PLANTER, PROVIDE 1\* PVC SLEEVES THROUGH MASONRY FOR DRIP IRRIGATION LINES.
- CONTRACTOR TO PRODUCE THE CUMMITTY OF BUITTERS BUSED ON THE ACTUAL PLANT COUNT AND THE BUITTER LEGISM SHOWN ABOVE. ANY REFERENCE TO BUITTER CHANNET FOR DESIGNA USE CHAY. ALL BUITTER TUBE OUTLETS SHALL HAVE, A BUG CAP AND PLASTIC TUBING STAKE INSTALLED, VERIET THE ACTUAL PLANT CUMMITTES AND SIZES FROM THE LANDSCAPE PLANS PRIOR TO BIDDING OR STARTING WORK.
- DRIP SYSTEM HAS BEEN DESIGNED TO ACCOMMODATE THE UPSIZING OF ENHITLES TO COMPENSATE FOR FUTURE PLANT GROWTH, MANTEMANCE PERSONNEL SHALL UPGRADE EMITTER SIZES AS REQUIRED TO PROVIDE ADEQUATE WATER FOR HEALTHY PLANT

### NOT SHOWN EMITTER NOT SHOWN EMITTER DRIP PAT. IRRIGATION SCHEDULE 6 10 0 # OF EMITTERS PLANT EMITTER LEDGEND RAD. PSI GPMGPH EMITTERS MANUFACTURER XB-20PC (FOR TREES

	EQUIPMENT	
MBOL	DESCRIPTION	MCOSIL.
0	IRRIGATION CONTROLLER	RAINBIRD ESP-LOMEF
I	BALL VALVE	NBC0 T-113
	DRIP VALVE WITH PRESSURE REGULATOR	RAINBIRD XCZ-109-PRB-COM OR XCZ-150-COM
9	TURF VALVE	RANBIRD XCZ-100-PRB-COM OR XCZ-150-COM
	QUICK COUPLER VALVE	RAINBIRD 44 LRC
-	FLUSH VALVE	FOHLFIPT
쩓		PERBUILDER
•	VALVE KEY  A * VALVE SECUENCE NUMBER B * VALVE SIZE  C = CPM	RANBRO 44K

200	PIPE AND WIRE	
SYMBOL	MANUFACTURER - MODEL NUMBER	
	MAINLINE: PVC SCH. 40 (2" MIN) - SEE CHART FOR SIZE	PIPE SIZING CHART
	LATERAL SHRUB LINE: 314" (MIN) POLY - SEE CHART FOR SIZE	GALLONS PER MINUTE
	LATERAL TREE LINE: 3/4" (MIN) POLY - SEE CHART FOR SIZE	9-6
derination (days)	LATERAL PALM LINE; 3/4" (MIN) POLY - SEE CHART FOR SIZE	12-22
	LATERAL TURF LINE: 8CH. 40 1° MIN CL 200; UNLESS NOTED OTHERWISE	22-35
	14" POLY - NOT SHOWN	35-60
	MAINLINE SLEEVES, PVC SCH. 40 - 2 TIMES (2X) DIA. OF MAINLINE PIPE BEING USED, UNLESS OTHERWISE NOTED; MIM. 4*	
	LATERAL SLEEVES, PVC SCH. 40 • 2 TIMES (2X) DIA. OF LATERAL PIPE BEING USED; UNLESS OTHERWISE NOTED; NIN. 2"	
	IRRIGATION SLEEVES PER UTILITY PLANS	
NOT SHOWN	NOT SHOWN CONTROL WIRE, UF DIRECT BURIAL, SOLID COPPER, 12 GA, COLLINON, 14 GA, PILOT	

8/09/2021

SHEET TITLE	
Irrigation	
Legend & Notes	

Scale: N.T.S.
Date drawn: 07-02-2021
Drawn by: IJ
Designed by: TT/JJ
Approved by: TT
Project #: 800755


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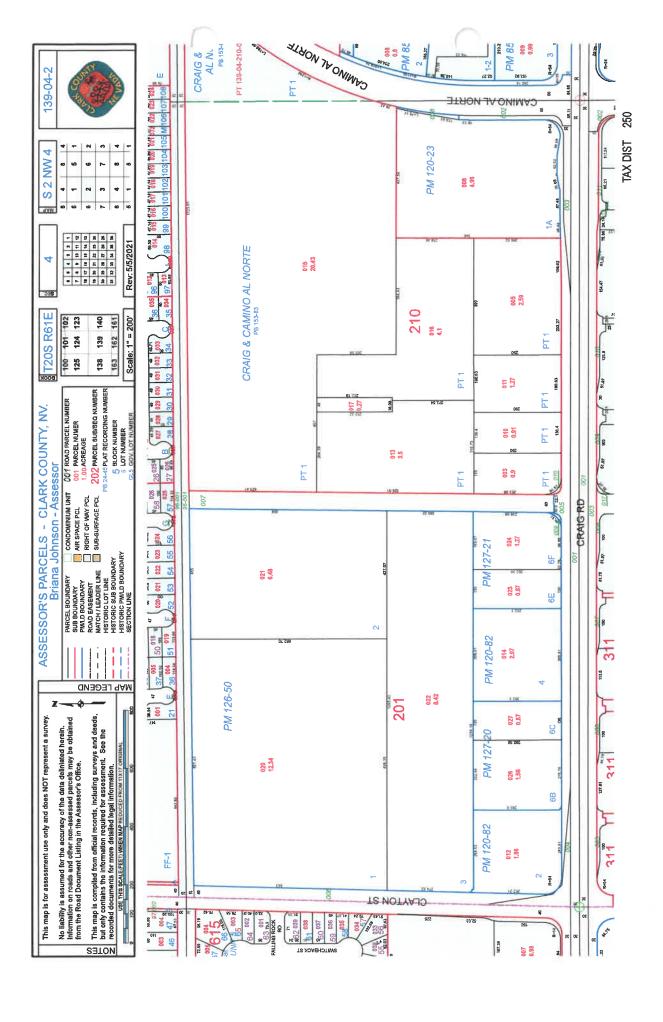
REVISIONS

PROJECT NAME Noble Peak Streetscape & Common Area
Richmond American 7770 S. Dean Martin Drive, Suite 308 Las Vegas, NV 89139



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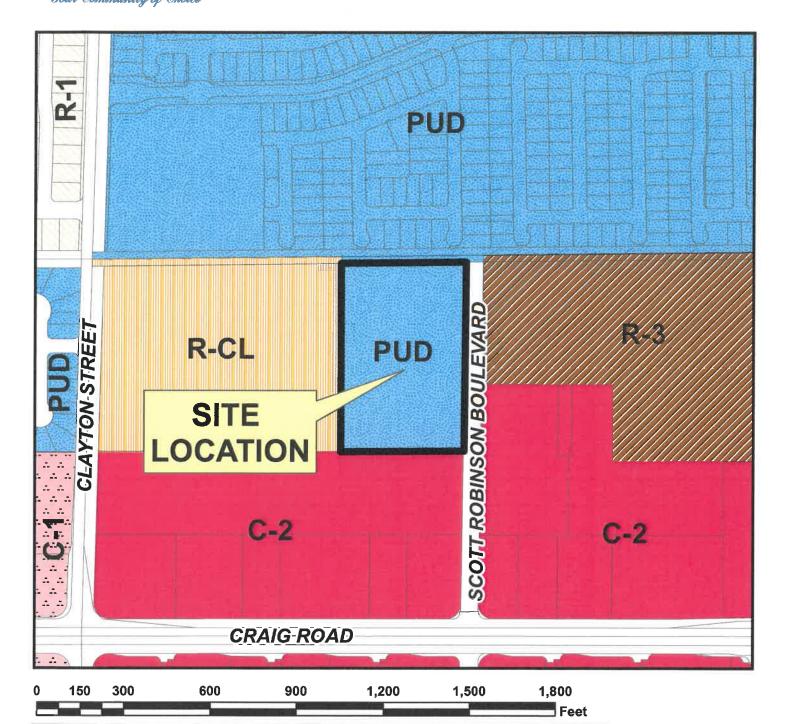


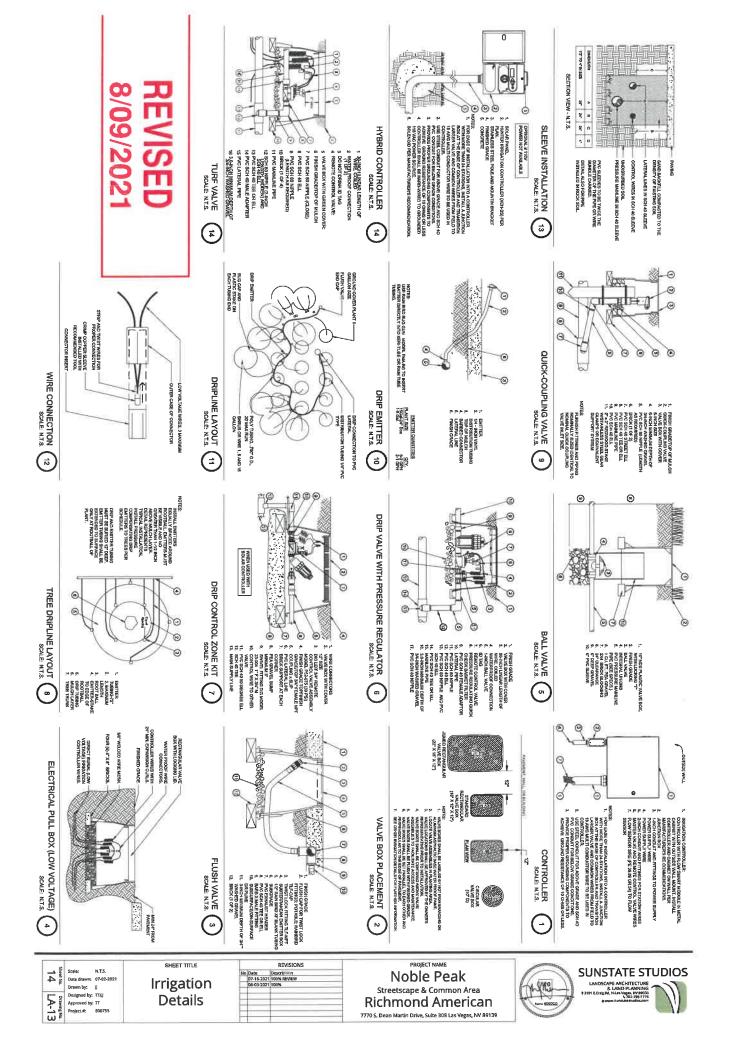

### CITY OF NORTH LAS VEGAS Your Community of Choice

### THE CITY OF NORTH LAS VEGAS

### **Location & Zoning Map**



Applicant: Richmond American Homes of Nevada, LLC

Application: Final Development Plan

Request: To Develop 70 Two-Family Homes

Project Info: West of Scott Robinson Boulevard, approximately 581 feet north

of Craig Road

Case Number: FDP-09-2021 8/5/2021

